


n.2 KIOSK SUBSTATION




LOCATION PLAN - Sub station Kiosk 01- Scale 1: 250




LOCATION PLAN - Sub station Kiosk 02- Scale 1: 250

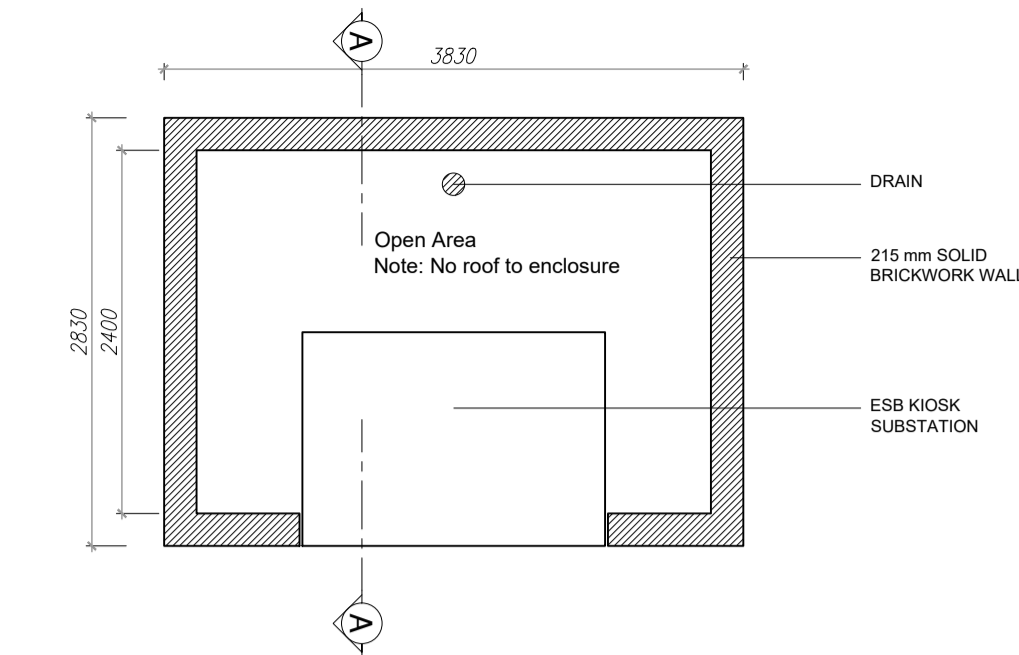


GROUND FLOOR PLAN - KIOSK 01 - 02
Scale 1: 50

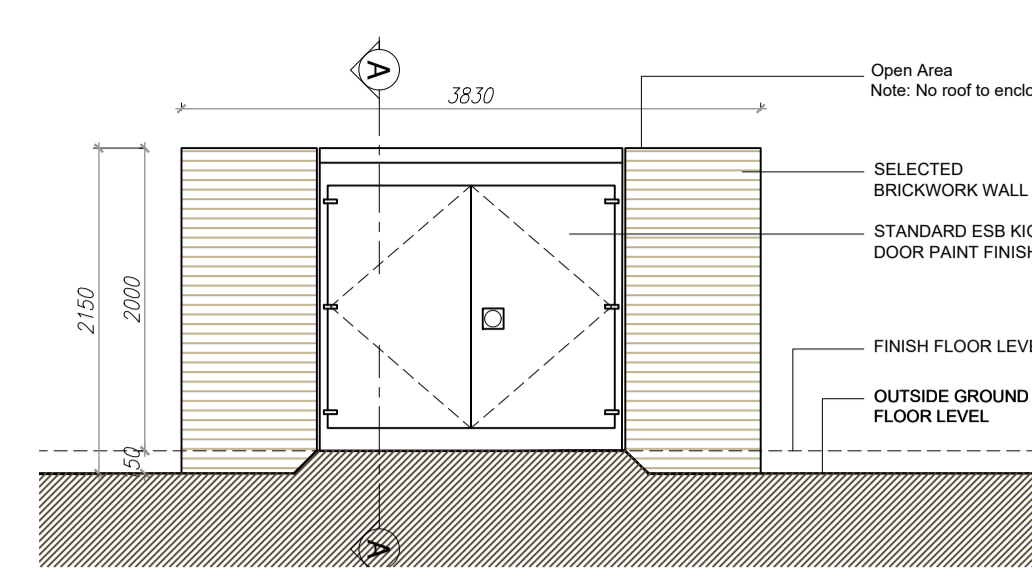

FRONT ELEVATION - KIOSK 01 - 02
Scale 1: 50

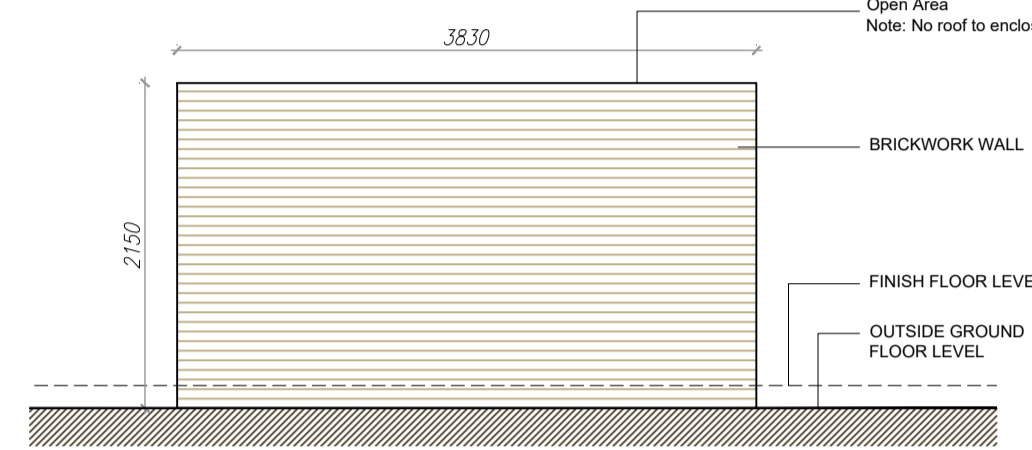


REAR ELEVATION
Scale 1: 50

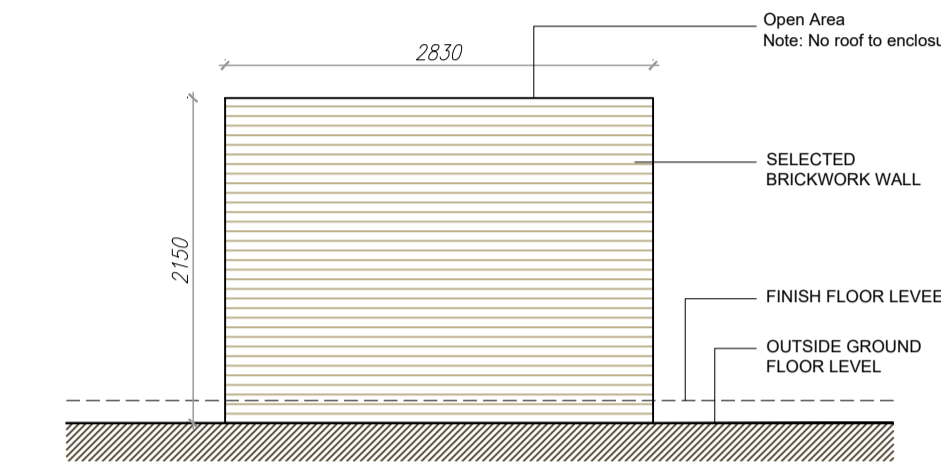

SIDE ELEVATION (Right and Left) - KIOSK 01 - 02
Scale 1: 50


GENERAL NOTES

THIS DRAWING TO BE READ IN CONJUNCTION WITH ARCHITECTS DRAWINGS, CONSULTANT ENGINEER'S DRAWINGS AND SPECIFICATIONS, AND LANDSCAPE ARCHITECT'S DRAWINGS AND SPECIFICATIONS.

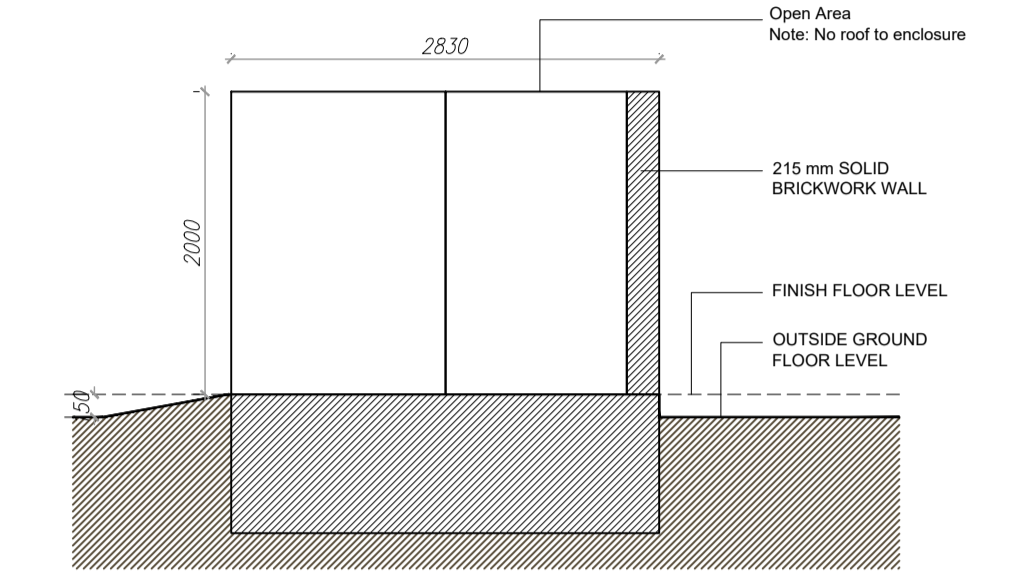


SECTION A-A - KIOSK 01 - 02
Scale 1: 50

n.1 SINGLE ESB SUBSTATION

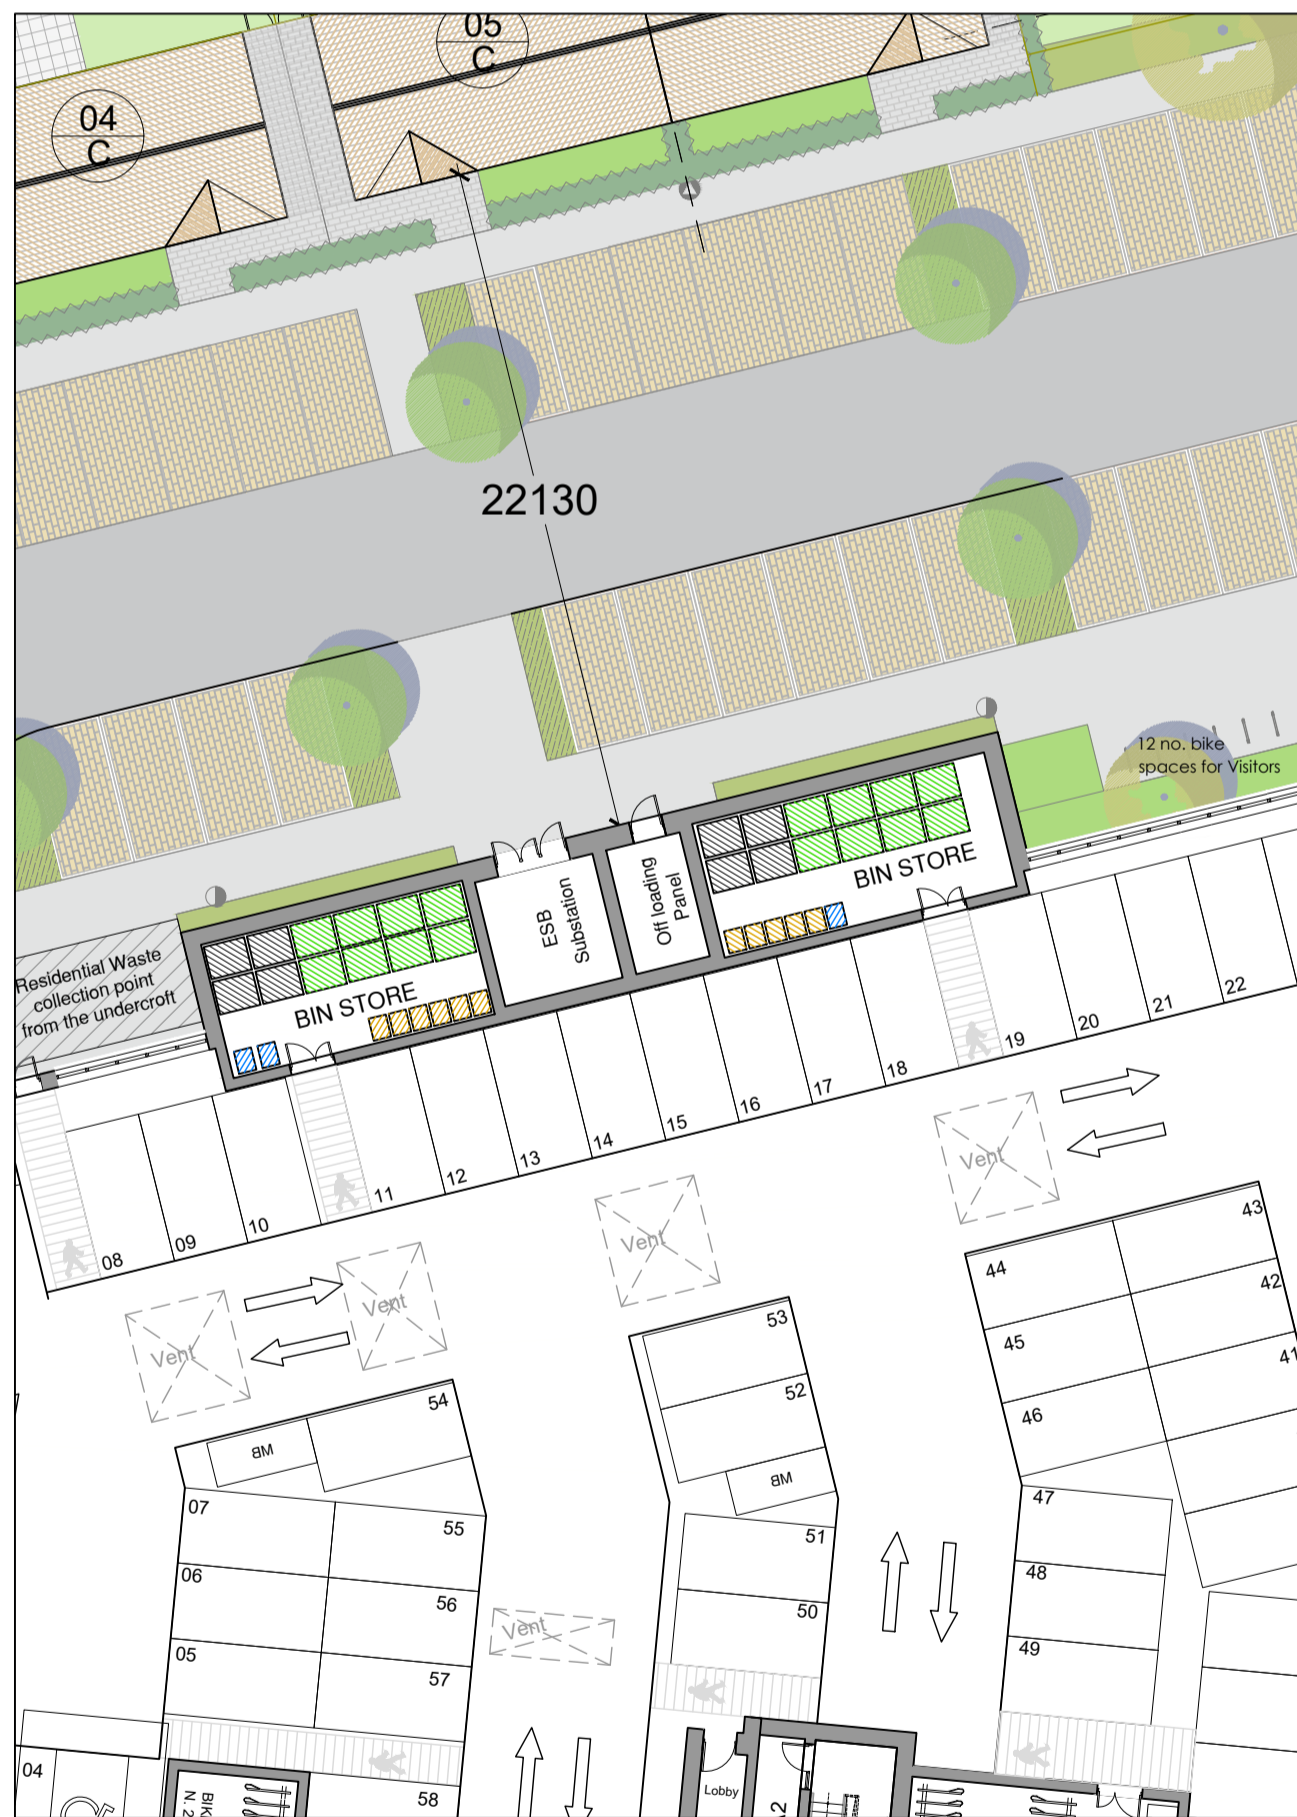


LOCATION PLAN - SINGLE ESB SUBSTATION Scale 1: 250


n.1 DOUBLE ESB SUBSTATION

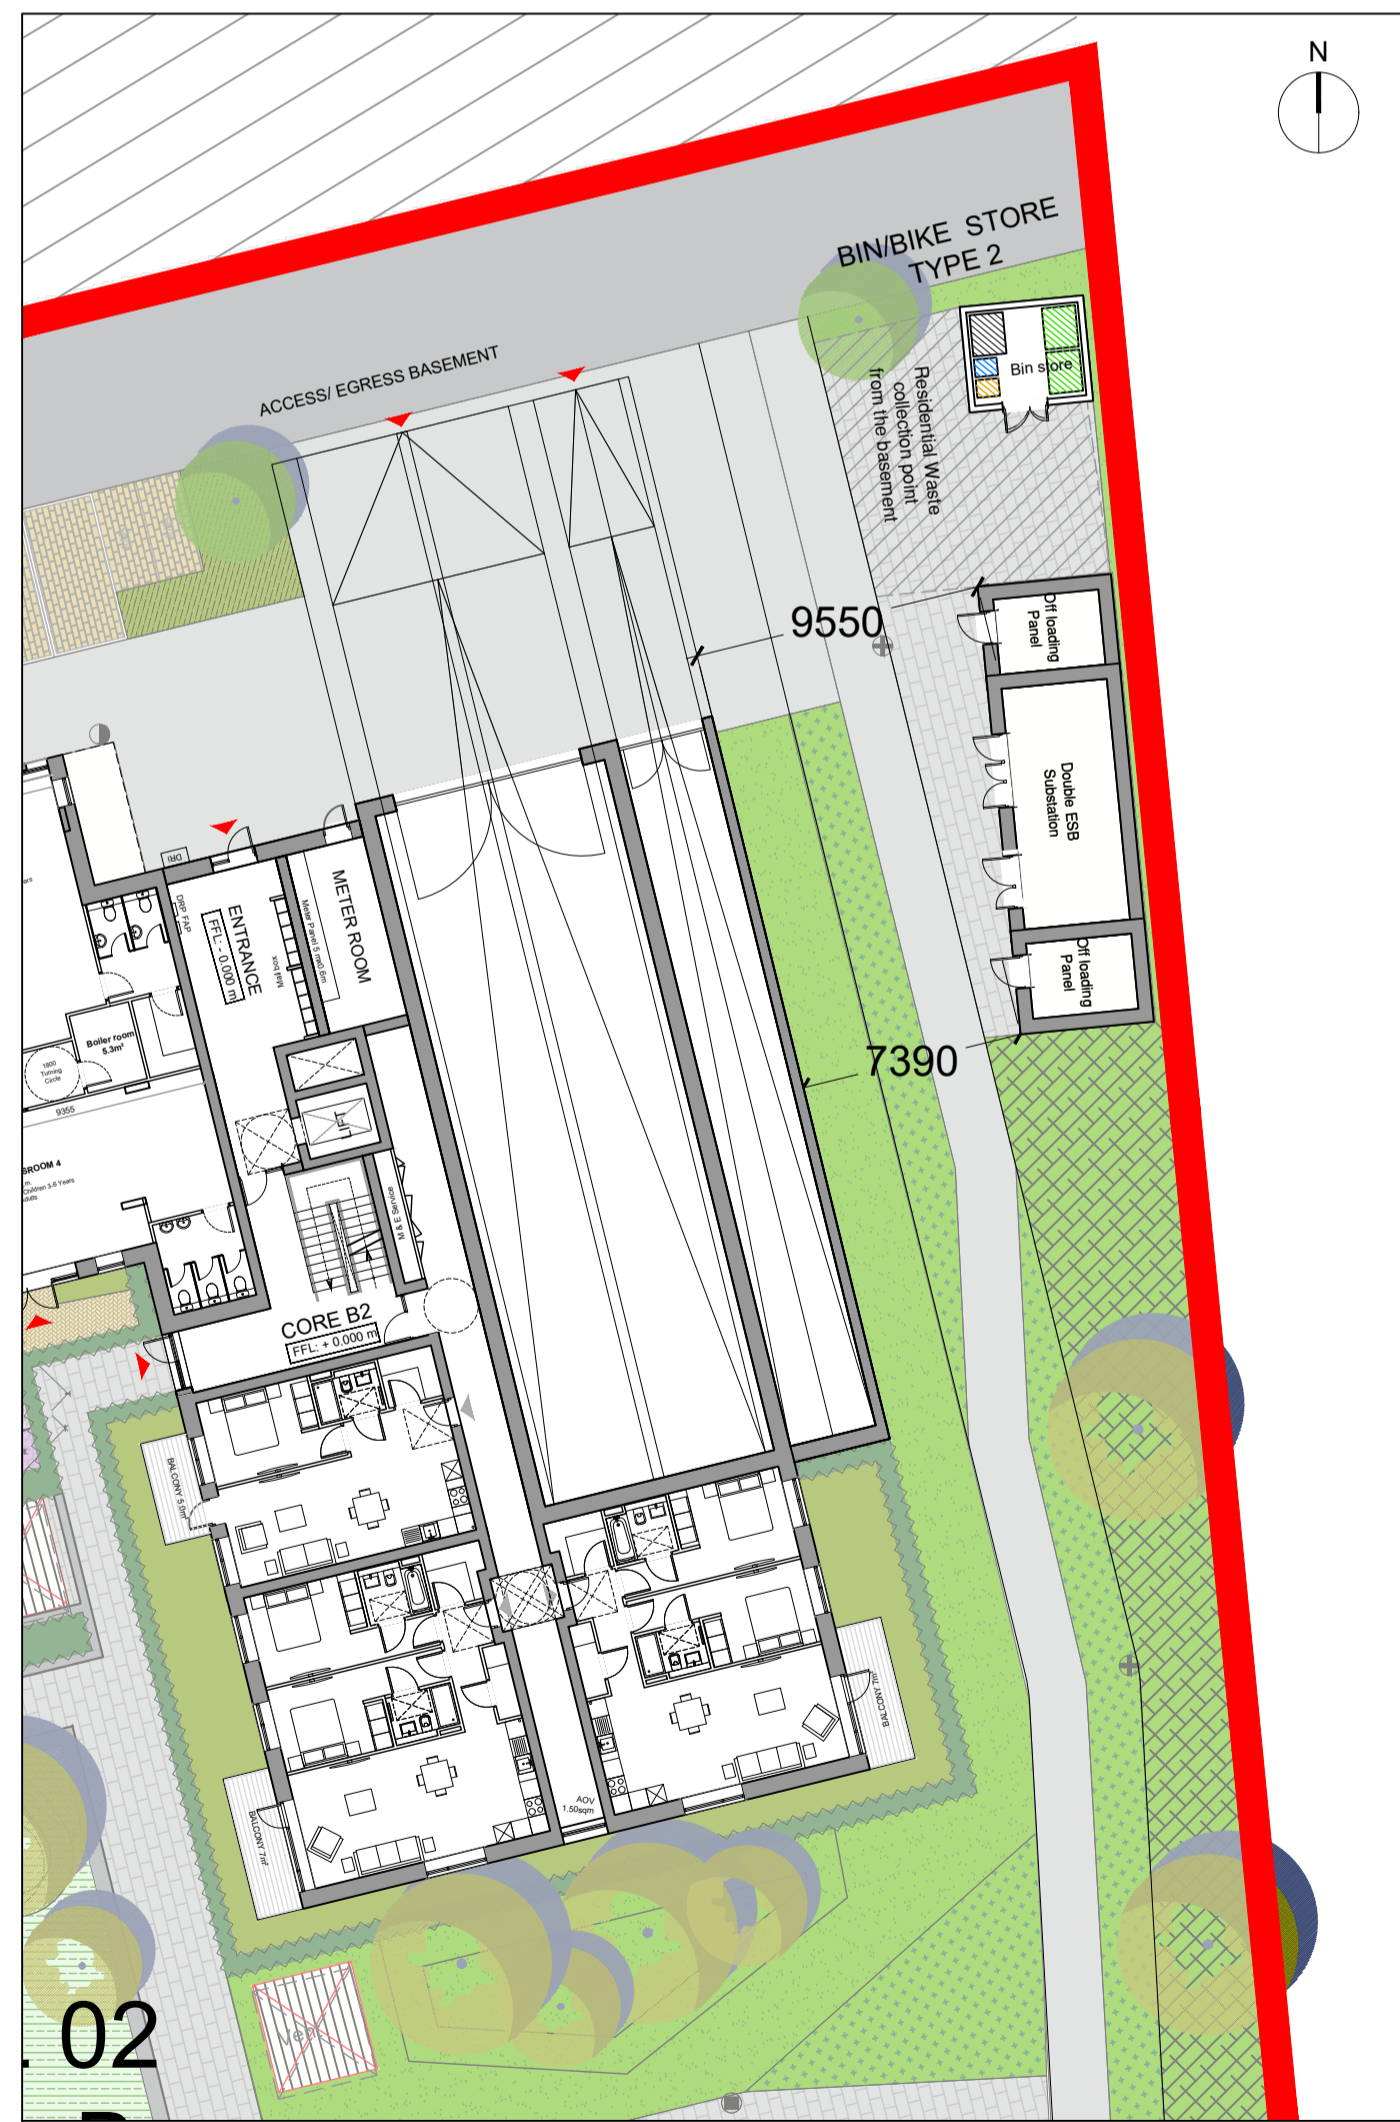


LOCATION PLAN - DOUBLE ESB SUBSTATION Scale 1: 250

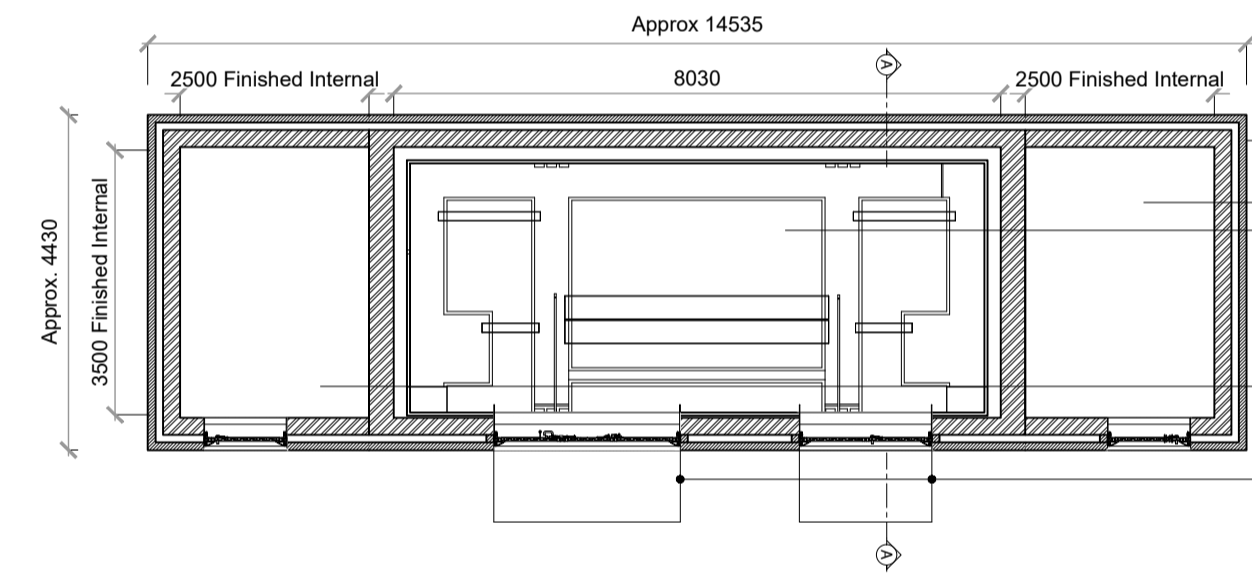


GROUND FLOOR PLAN - DOUBLE ESB SUB STATION _ Scale 1: 50

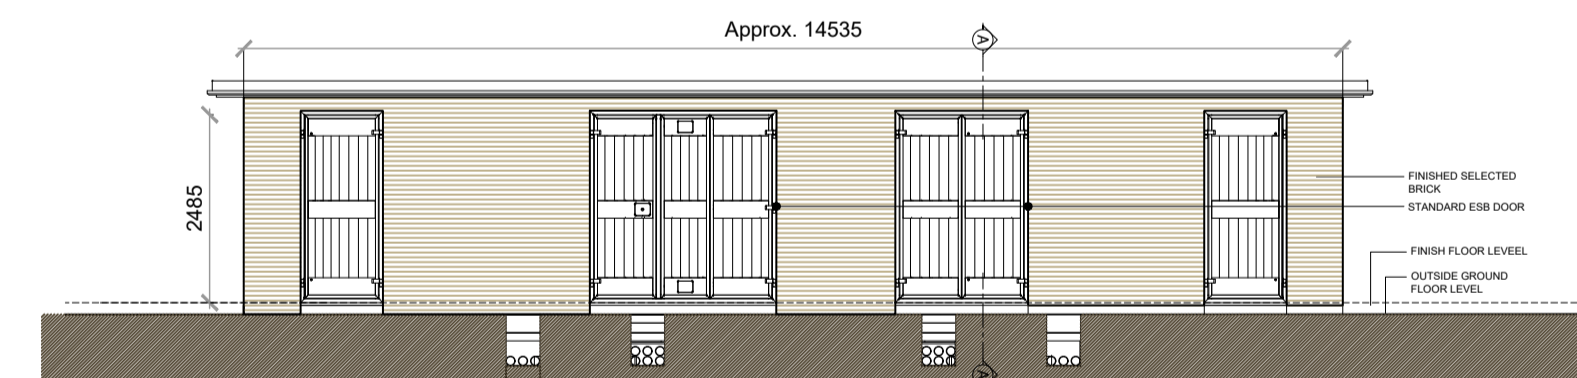

FRONT ELEVATION - DOUBLE ESB SUBSTATION _ Scale 1: 50

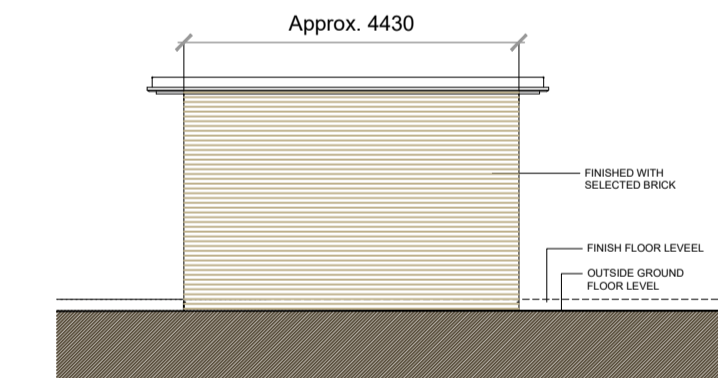

SECTION A-A _ Scale 1: 100
SIDE ELEVATION (Right and Left)
Scale 1: 100

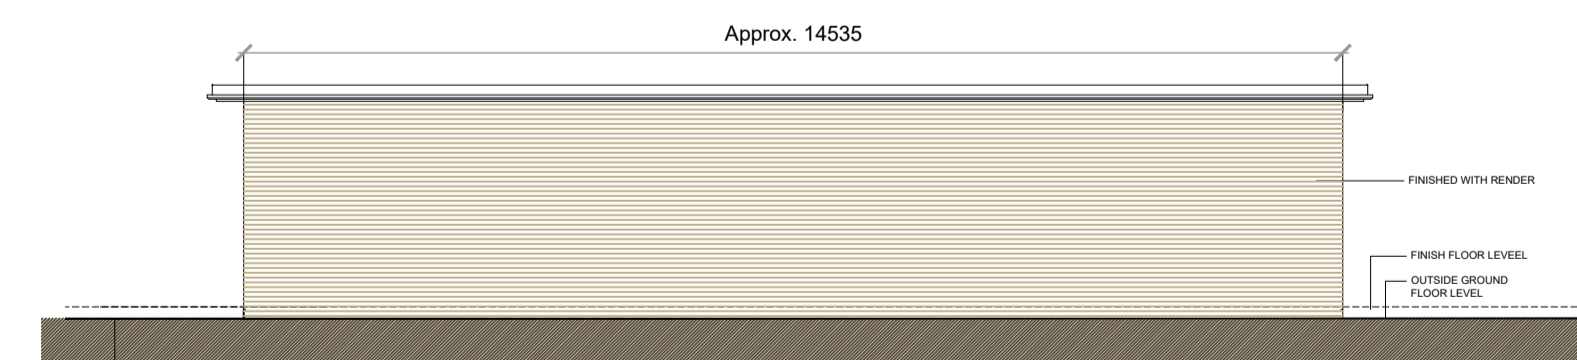

REAR ELEVATION - DOUBLE ESB SUBSTATION _ Scale 1: 50

- Single standard ESB and Off-Loading Panel are designed as per standard details of the double ESB-Substation
- Single ESB-Substation is designed as part of the undercroft.
- For additional details in elevation and section: PLEASE REFER TO ARCHITECTS DRAWING PL 50-51 Block A Elevations & Sections

NOTES:

DO NOT SCALE FROM DRAWINGS. WORK TO FIGURED DIMENSIONS ONLY. ARCHITECT TO BE NOTIFIED OF ALL DISCREPANCIES.

CLIENT:		REVISIONS	
DATE	DESCRIPTION	DATE	No.
CAIRN	CAIRN Homes Properties Ltd		

	PROJECT TITLE:	DATE:	DRAWN BY:
	SHD AT HOLYBANKS, SWORDS	Mar'22	IDF
	DRAWING TITLE:	SCALE:	REVISION:
	Kiosk and ESB Substation Details	varies@A	
	JOB NO:	DRAWING NO:	
	19022	PL69	